Item: 4

DC/21/0615/FUL

Change of Use from former water tower to dwelling and extension

Water Tower
Tuddenham Lane
Rushmere St Andrew



Application Site



Site Location Plan Tower House Mulberry Corner Modern Water Tower **Application Site**

oogle Streetview Link

Aerial Photograph




Application Site











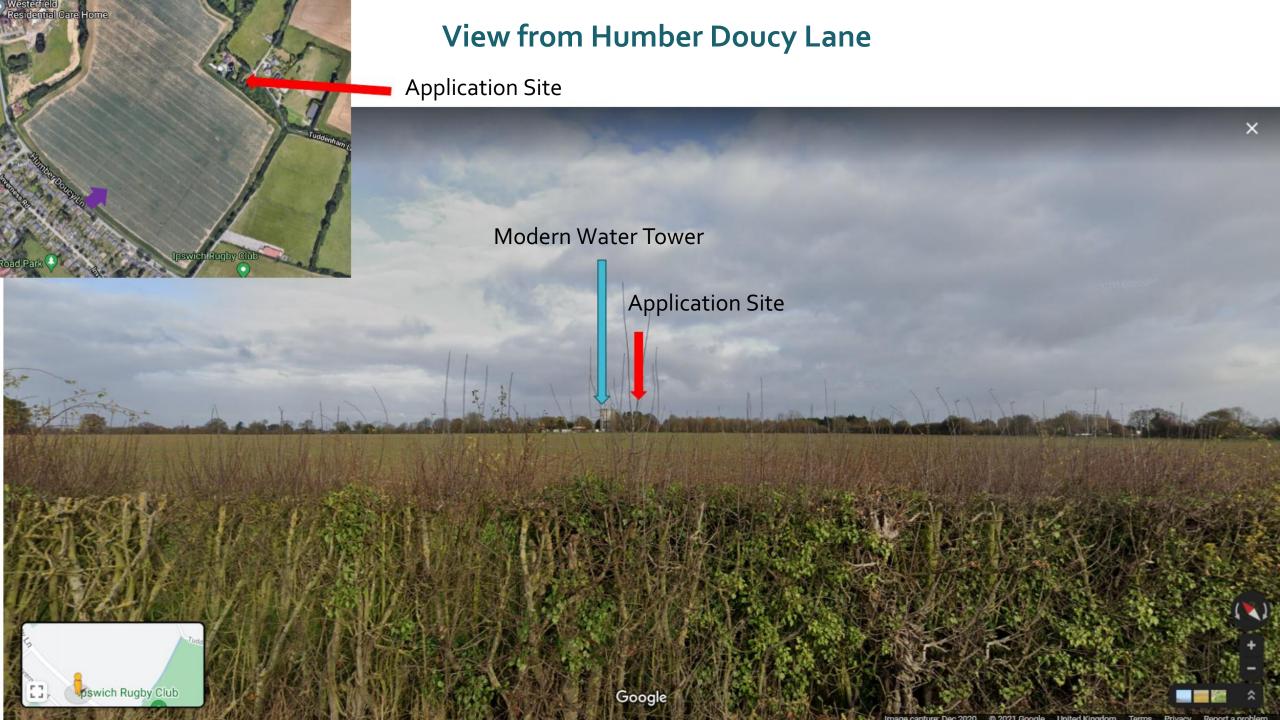



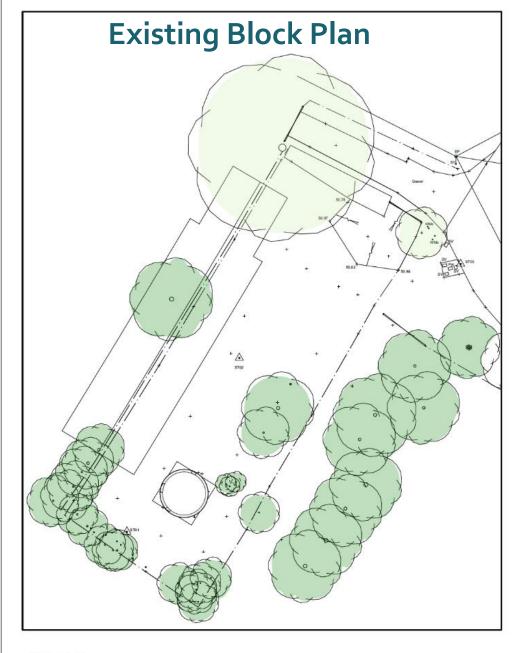

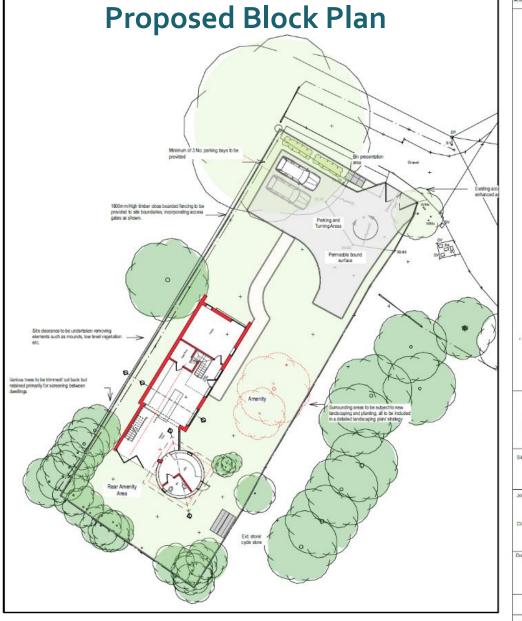

Site Location: Water Tower at Tudderham Lane, Rushmere, bawich

Job Title: Conversion and extension of water tower to residential dealing

Charit Mr Willia:

Drawing Name

EXISTING & PROPOSED SITE PLAN

P L A N N I N G

Drawing Scale

1250 At A 2 Size

Legout ID 20-061 A-PL-03

Existing Site Plan

Scale: 1:250

0 fee 3m 5m for 10m


Proposed Site Plan

Scale: 1:250

0 fine 3m 5m 1



Proposed Cross- Sections

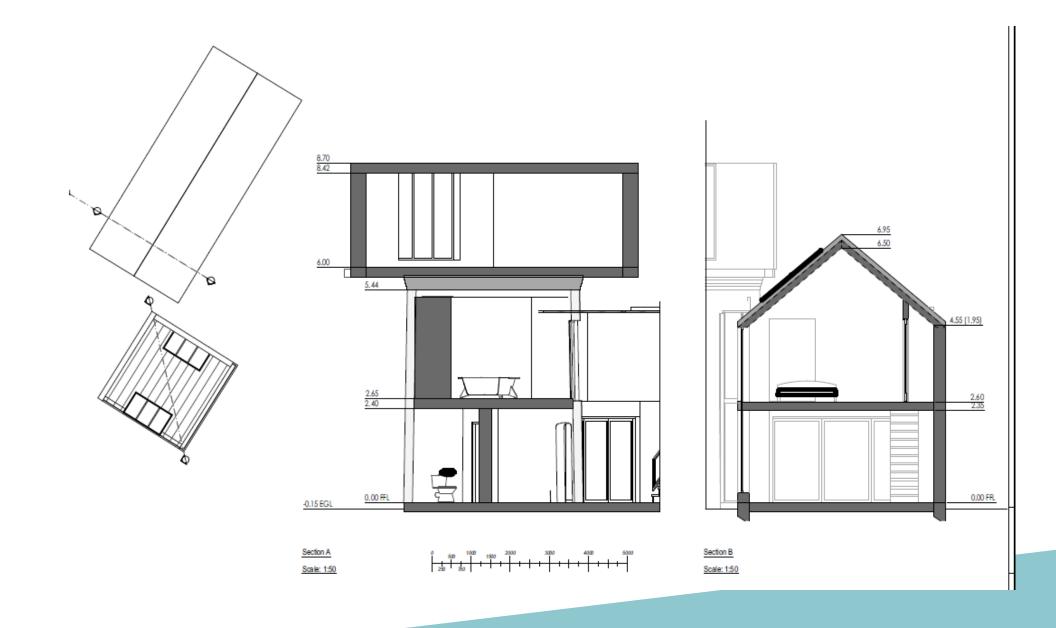

Proposed Elevations



South West Elevation

North East Elevation



South East Elevation



North West Elevation

Proposed materials/ finishes



'Corten Steel' dadding affixed to manufacturers instructions



Zinc cladding applied to water tower structure with rolled joints.



Bricks, Weinerberger, Athena blend, lime based mortar joints







Material Planning Considerations and Key Issues

- Principle of Development (redundant building in the countryside)
- Design and Heritage
- Residential Amenity
- Highway Safety
- Habitats /off-site Ecology
- On site Ecology

Recommendatio

- Authority to Determine with approval being granted subject to no objections being raised by the Highways Authority that have not been previously considered. Otherwise, to refuse as necessary on highway safety grounds. Approval to be subject to controlling conditions including those summarised below:
 - 1) Standard 3 year time limit for implementation
 - 2) Drawings/Plans
 - 3) Schedule of Repairs for water tower
 - 4) Materials and detailing
 - 5) Heritage Impact Assessment to be deposited with SCC Historic Environment Record
 - 6) Compliance with Phase 1 contamination Assessment
 - 7) Unidentified contamination
 - 8) Compliance with Arboricultural Method Statement
 - 9) Compliance with Ecological avoidance, mitigation and compensation and enhancement measures.
 - 10) No removal of vegetation in bird nesting season unless site checked by ecologist
 - 11) No external lighting without prior agreement
 - 12) Method statement for Great Crested Newts and Barn Owls
 - 13) Licence from Natural England



Applicant/Agent



